CITY OF SOMERVILLE PLANNING BOARD APPLCATION

REVISION TO LANDSCAPE PLANS

PREVIOUSLY FILED ON JUNE 12, 2023

APPLICANT: SGL Development, Inc.


SUBJECT PROPERTY: 32-40-44 White Street, Somerville, Massachusetts

CASE NUMBER: P&Z 22-054

The Applicant is replacing the previously submitted file entitled "White St 32-44-Landscape Plans-2023-6-12" with this new file entitled "White St 32-44-Landscape Plans -2023-6-23" to make the following changes:

- Revise the following Sheets in response to PSUF comments to increase the size of the bioswale, and revise the Green Score calculation and green roof, and to provide more soil details:
 - o L-1
 - o L-2
 - o L-3
 - o L-4
 - o L-5



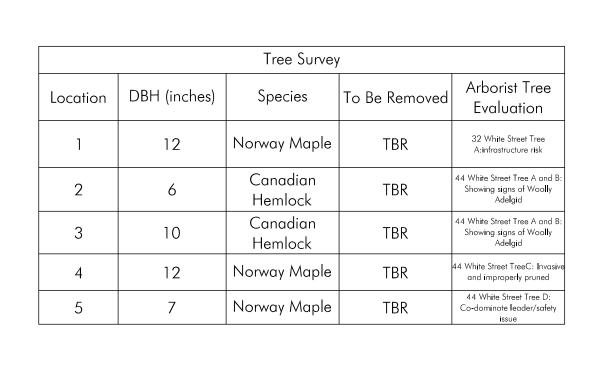

Ab	Abutter's Tree Survey (Trees in good health)					
Location	DBH (inches)	Species	To Be Removed			
6	12	Norway/Elm	TBR			
7	10	Norway/Elm	TBR			
8	12	Norway/Elm	TBR			
9	12	Norway/Elm	TBR			
10	10	Norway/Elm	TBR			
11	12	Norway/Elm	TBR			
12	10	Norway/Elm	TBR			
13	10	Norway/Elm	TBR			

AREA= 5,000 SF±


N 58°21'51" E


\$ ¥ 43.51 **→**SOMERVILLE 43.27

53.46'(M) 52.54'(R) N 58°21'51" E

Tree Mitigation					
	Caliper of Trees To Be Removed	Total Caliper of Proposed Trees			
Existing Trees TBR (DBH)	47				
Abutter's Tree TBR (DBH)	88				
Proposed Trees		27.5			

DBH = Diameter at Breast Height = trunk diameter measured 4 $\frac{1}{2}$ feet from the ground CAL = Caliper = Diameter at Breast Height = trunk diameter measured 4 $\frac{1}{2}$ feet from ground

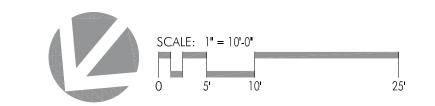

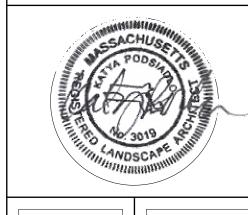


32-44 white street somerville, ma

Project #:	Date:06/21/23
Drawn by: WK	Reviewed: KP
Scale: 1" = 10'-0"	

TREE SURVEY PLAN

Revisions:

L1

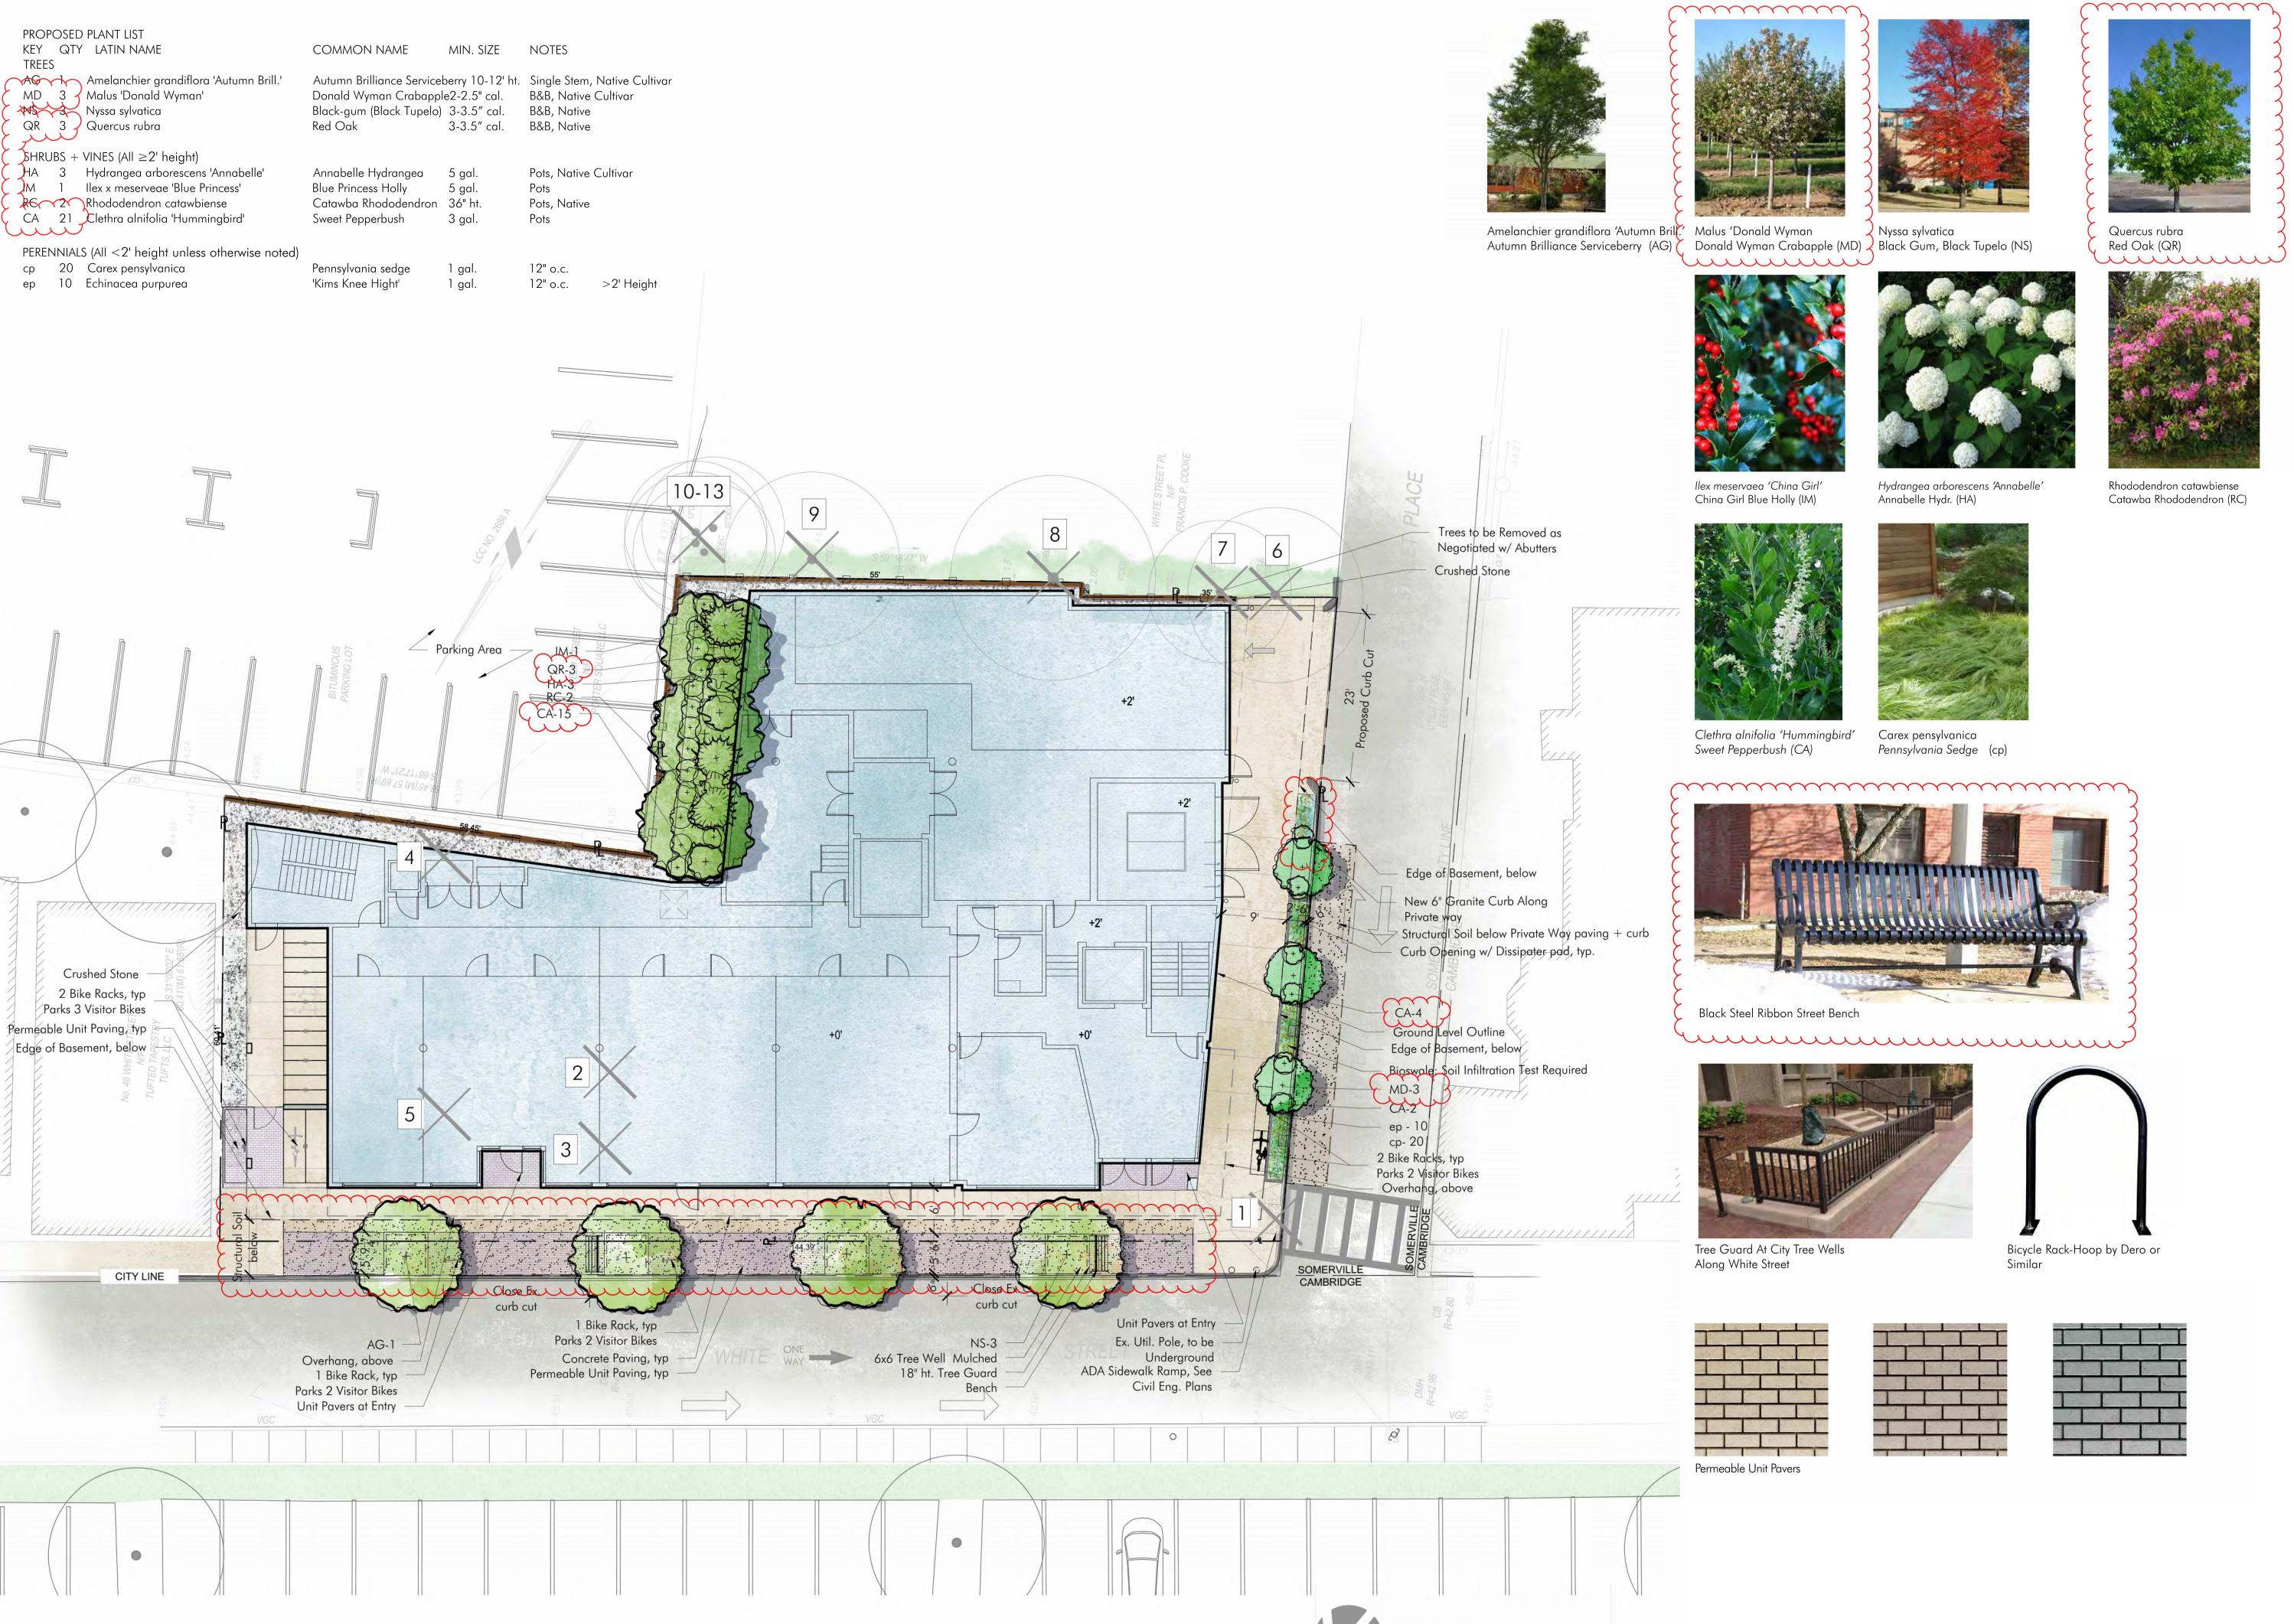

VERDANT
LANDSCAPE ARCHITECTURE
318 Harvard Street, Suite 25, Brookline, MA 02446
Verdant Landscape Architecture.com 617.735.1180


LANDSCAPE PLAN 32-44 WHITE STREET SOMERVILLE, MA

Date:06/21/23 Reviewed: KP Project #:
Drawn by: WK
Scale: 1" = 10'-0"

Revisions:


- 1. Edge restraints vary see plan.
- 2. All aggregate material shall be crushed, angular stone and free of fines.
- Compact subsoil with a California bearing ratio (cbr) of less than 5% as directed by a professional engineer.
- 4. Surface slope shall be a minimum of 1% and a maximum of 5%.
- 5. Never build permeable pavements on organic clay soils of high plasticity and/or peat, mulch, soils with high organic content.
- Maintain a minimum distance of 2' between bottom of permeable base and water table.
- 7. The minimum aggregate thicknesses are after compaction.

CRUSHED STONE DETAIL

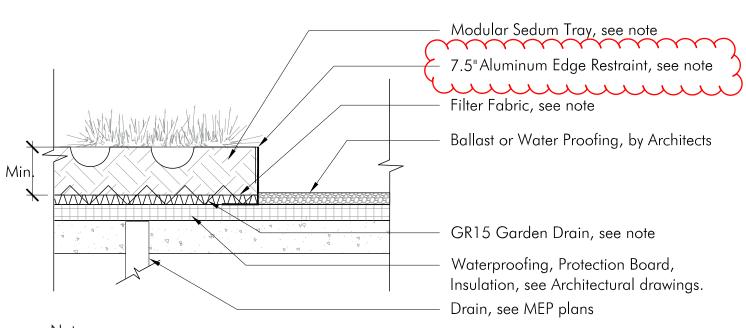


- 1. Modular Sedum Tray: LiveRoof Edge-Deep System, 6" depth, by LiveRoof, Prides Corner Farms is local Representative (860)-710-8512
- 2. Aluminum Edge Restraint by LiveRoof, Min. 7.5" ht.
- 3. Drainage Mat by Hydrotech GR-15

6" MIN DEPTH LIVEROOF DETAIL

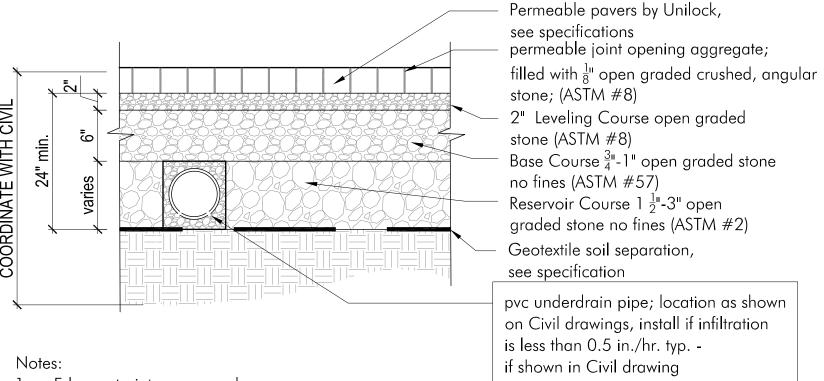


- 1. Edge restraints vary see plan.
- 2. All aggregate material shall be crushed, angular stone and free of fines.
- 3. Compact subsoil with a California bearing ratio (cbr) of less than 5% as directed by a professional engineer.
- 4. Surface slope shall be a minimum of 1% and a maximum of 5%.
- 5. Install pvc underdrain pipe where infiltration rate of subsoil is less than 0.5 in./hr. size as directed by a professional engineer.
- 6. Never build permeable pavements on organic clay soils of high plasticity and/or peat, mulch, soils with high organic content.
- 7. Maintain a minimum distance of 2' between bottom of permeable base and water table.
- 8. The minimum aggregate thicknesses are after compaction.

PERMEABLE UNIT PAVER DETAIL

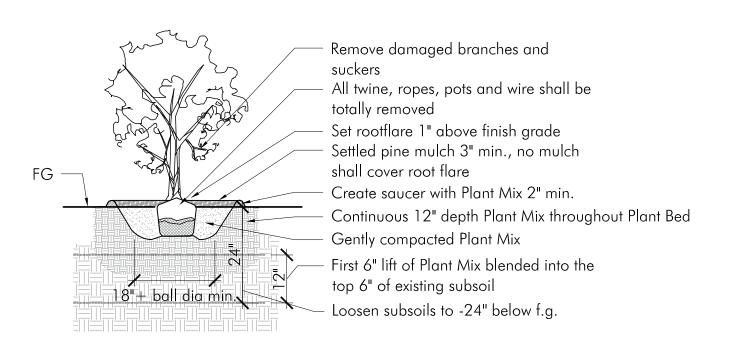


TYPICAL PLANT (TREE OR SHRUB) DETAIL SCALE: 1/2" = 1' - 0"


THIS GREEN SCORE CALCULATOR SHOWS EVERYTHING WITHIN THE PROPERTY LINE.

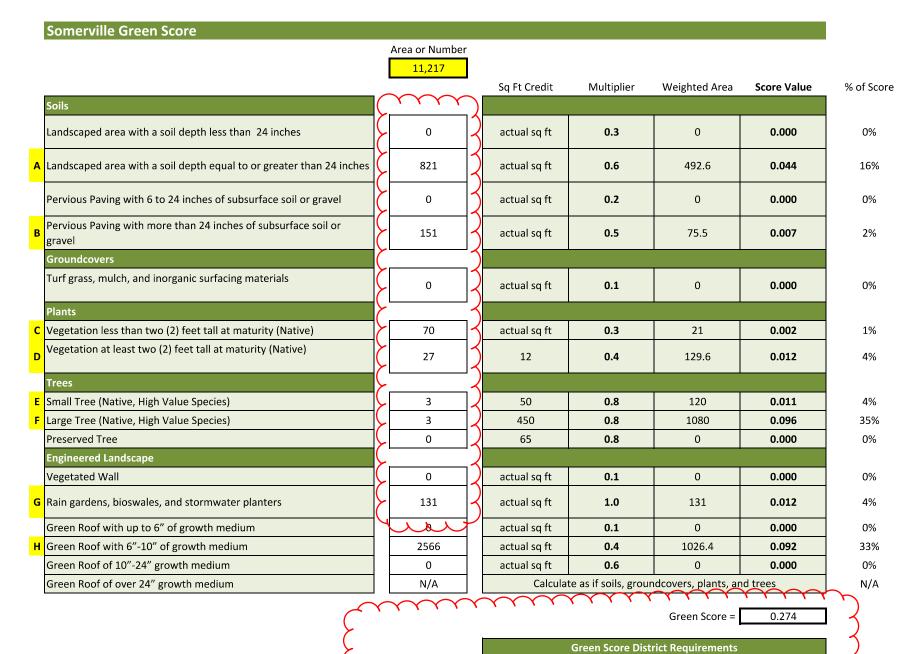

	NR & UR	MR3 & MR4	MR5, MR6, & HR	FAB, CC, CB, CI				
Required Score:	0.35	0.25	0.20	0.20				
Target Score:	0.40	0.3	0.25	=				
Actual Green Score:	0.274	0.274	0.274	0.274				
White halt in the state of the								
	Possible Bonuses							
		Publicly Visibl	Publicly Visible Landscape 0.1					

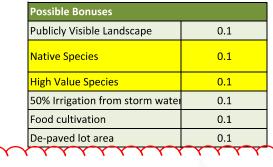




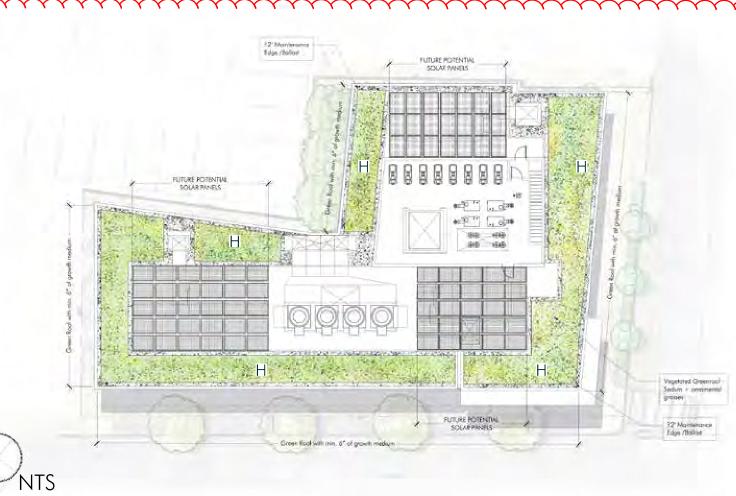

GREENROOF PLAN



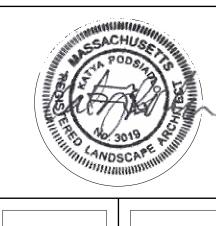


CALCULATION SCORE GREEN

Project #:
Drawn by: WK
Scale: 1" = 10'-0" Date:06/21/23 Reviewed: KP

32-44 WHITE STREET SOMERVILLE, MA

Revisions:

rain garden detail SCALE: 3/4'' = 1'-0''

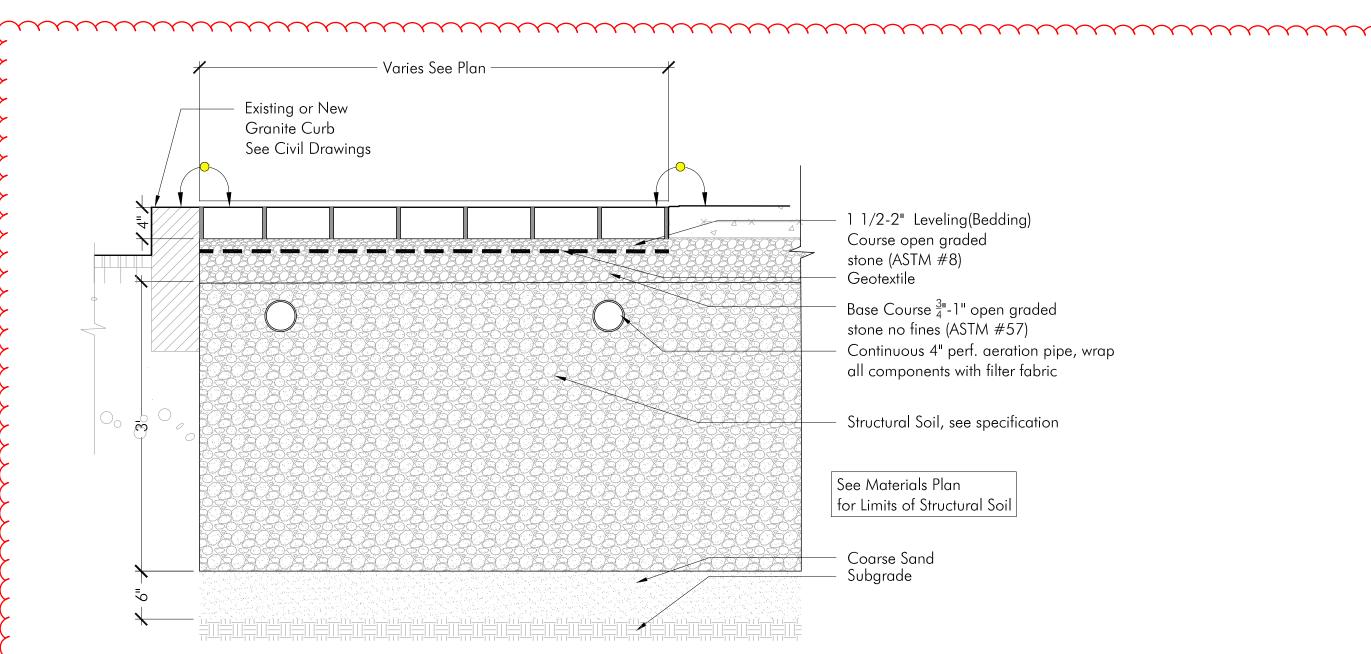

1. Permeable Paver by Techo-bloc, Hydra color 5. Surface slope shall be a minimum of 1% and a shall be Shale Grey ($7\frac{7}{8}$ "x11 $\frac{13}{16}$ "x 3 15/16" thick), See Specifications

2. Edge restraints shall be Pave Edge Pro Rigid by Pave Tech pavetech.com, Follow manufacturers installation instructions

- 3. All aggregate material shall be crushed, angular stone and free of fines.
- 4. Compact subsoil with a California bearing ratio 8. Maintain a minimum distance of 2' between (cbr) of less than 5% as directed by a

professional engineer. Install pvc underdrain pipe where infiltration rate

of subsoil is less than 0.5 in./hr. size as directed by a professional engineer. 7. Never build permeable pavements on organic

clay soils of high plasticity and/or peat, mulch, soils with high organic content. bottom of permeable base and water table. 9. The minimum aggregate thicknesses are after

compaction.

PERVIOUS PAVERS AND STRUCTURAL SOIL DETAIL SCALE: 1'' = 1'-0''

STREET TREE PLANTING AND STRUCTURAL SOIL DETAIL

Existing or New Granite Curb

Varies

🖊 See Plan + 🗡

Enlargements

See Civil Drawings

- See Plan + 🛶

Enlargements

carefully prune damaged branches and

from top of rootball set crown of rootball so that geogrid can extend over rootball.

Contractor shall remove excess fill

Remove burlap and rope from top $\frac{1}{3}$

If tree is in a wire basket, cut away as much of basket as possible once

second leader(s)

the tree is placed.

rounded peastone

Drawings

- Pave Edge Standard Rigid, as per mfr specifications

Stone at Opening shall be $\frac{3}{8}$ "

Concrete Sidewalk, See Civil

- 1 1/2-2" Leveling(Bedding)

Course open graded stone (ASTM #8)

for Limits of Structural Soil

Base Course $\frac{3}{4}$ -1" open graded stone no fines (ASTM #57)

Aeration Pipe: Continuous 4" perf. aeration pipe around

perimeter of tree well, provide

capped riser with black drain

grate set flush with grade,

wrap all components with

D-Man Platipus Anchoring

or Other Guy Wire + Stake System

System with Plati-mat


filter fabric

Coarse Sand

Subgrade

See Materials Plan



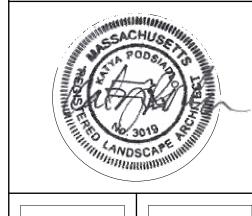


CALCULATION SCORE GREEN

Date:06/21/23 Reviewed: KP Project #:
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32-44 WHITE STREET SOMERVILLE, MA

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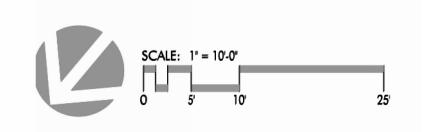





MAINTENANCE EDGE/ BALLAST

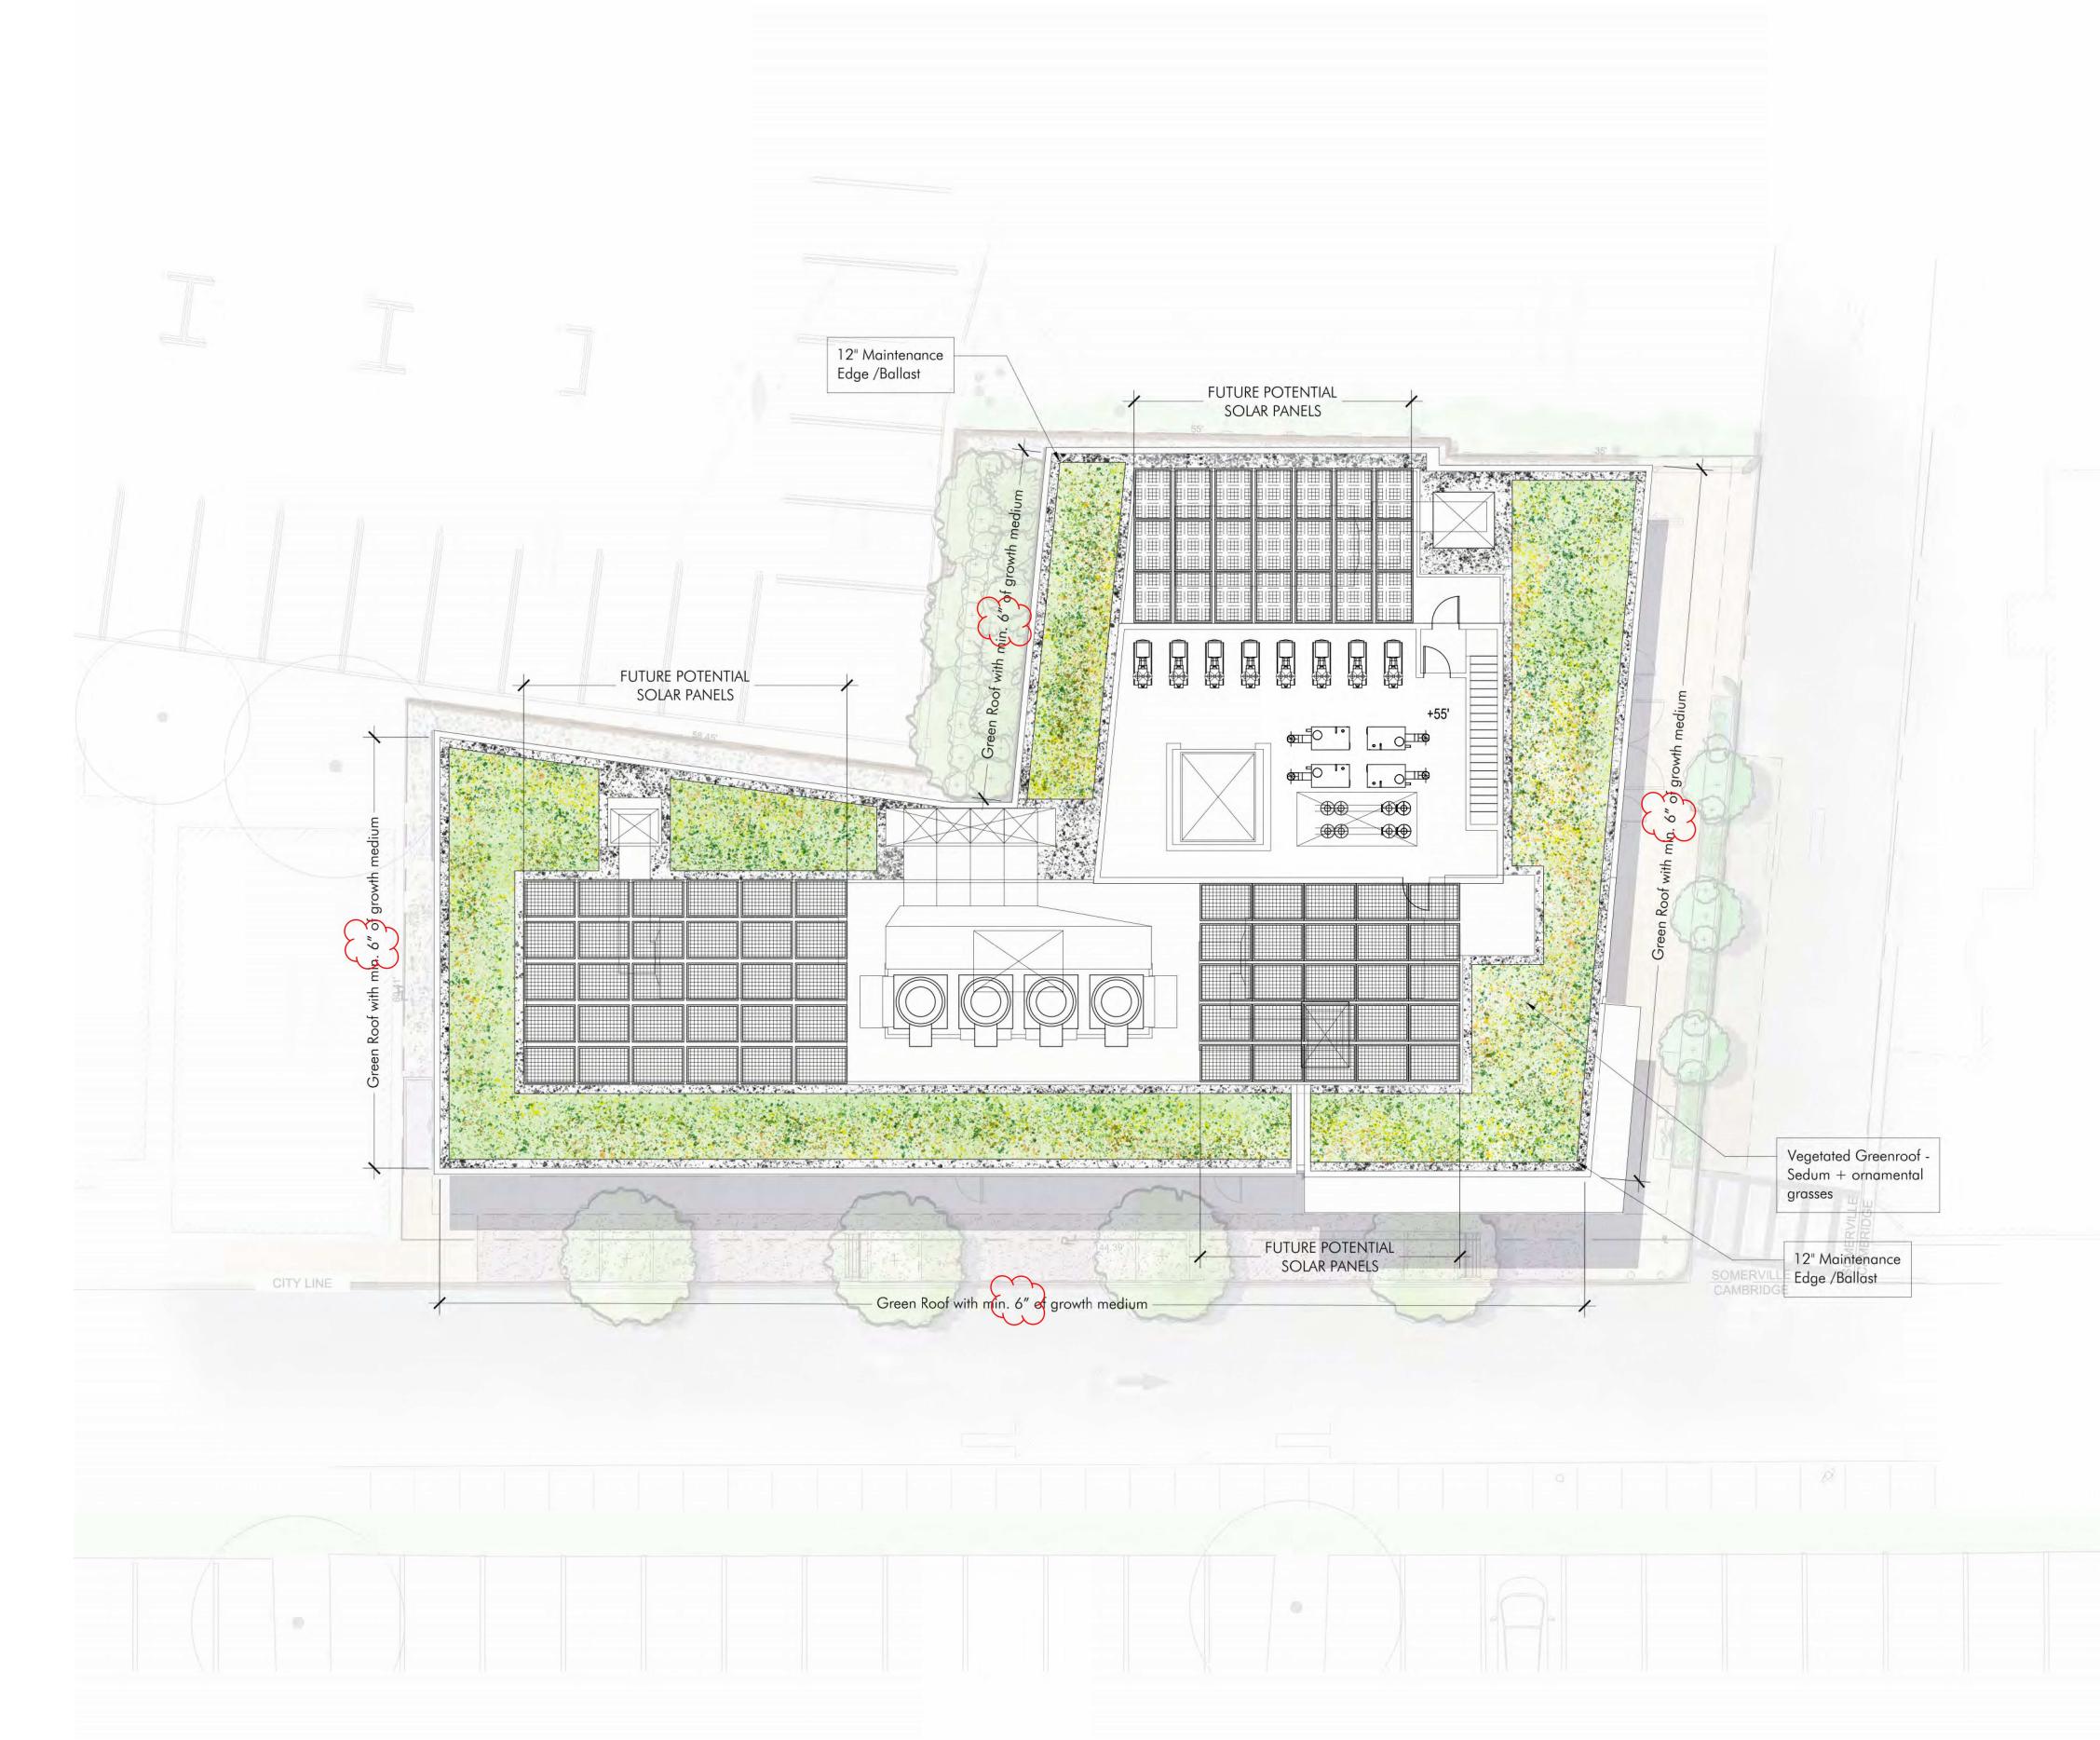

PRE-VEGETATED LIVEROOF MODUAL SEDUM TREYS





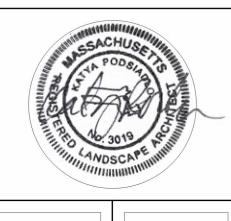

32-44 white street somerville, ma

GREENROOF PLAN

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